



Walters Buildings

Jack Walters & Sons, Corp.
P.O. Box 388
6600 Midland Ct.
Algerton, WI 53002
1-800-558-7800
www.waltersbuildings.com

**DRAWINGS
IN PROGRESS**

OWNER NAME:
TCTS, LLC.

OWNER ADDRESS:
2626 49th DR.
FRANKSVILLE, WI
53126

PROJECT NAME:
60x125 STORAGE
BUILDING

PROJECT ADDRESS:
2626 49th DR.
FRANKSVILLE, WI
53126

SALES REP / DEALER:
JOSH OBERT

DRAFTER:
DAVID MERKEL

ESTIMATOR:
EVAN ROGERS

LAST SAVED BY:
DMERKEL ON: 12/17/2024

PAPER SIZE:
ARCH PALL BLEED C (18.00 X 24.00 INCHES)

SCALE:
AS NOTED

ENGINEER:
CAYNEN KLESSIG


JOB NUMBER:
94-0805

SHEET NUMBER:


A1

DOOR & WINDOW SCHEDULE


MAINTAIN LEVEL APPROACH TO ALL WALKDOORS		*FIELD VERIFY ALL WINDOW SILL HEIGHTS*	
TAG	TYPE	ROUGH OPENING W x H	QUANTITY
①	14'x14' OVERHEAD DOOR	14'x14'	5
②	3'x6'-8" THERMAL BREAK WALK DOOR W/INTERCONNECTED DEADBOLT LEVERSET	FIELD VERIFY	9
③	4'x3' HORIZONTAL SLIDING WINDOWS	48"x36"	7

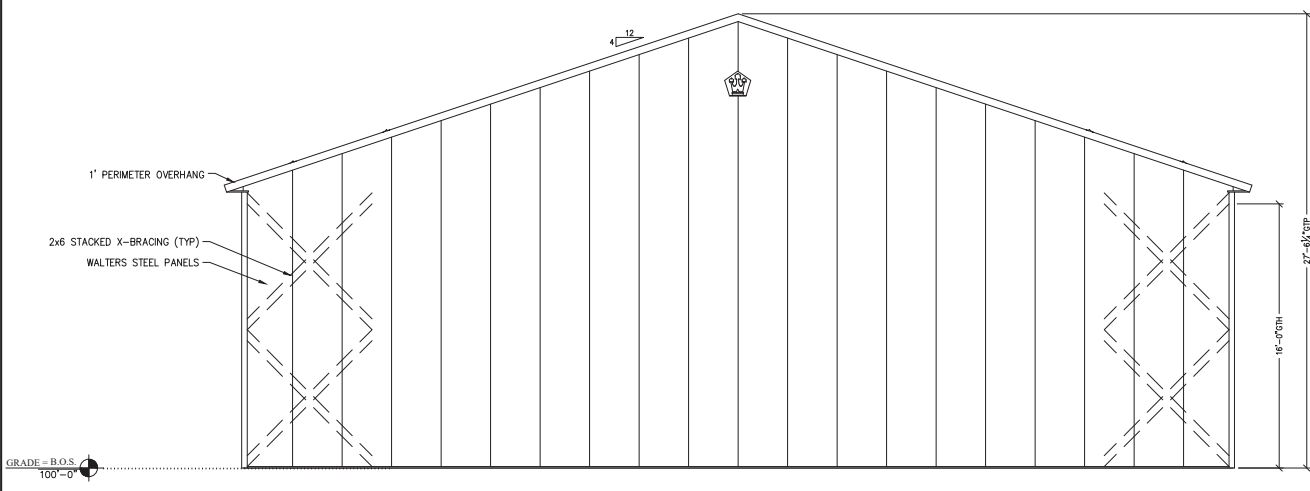

1 LEFT END ELEVATION
A1 SCALE: 3/16" = 1'-0"

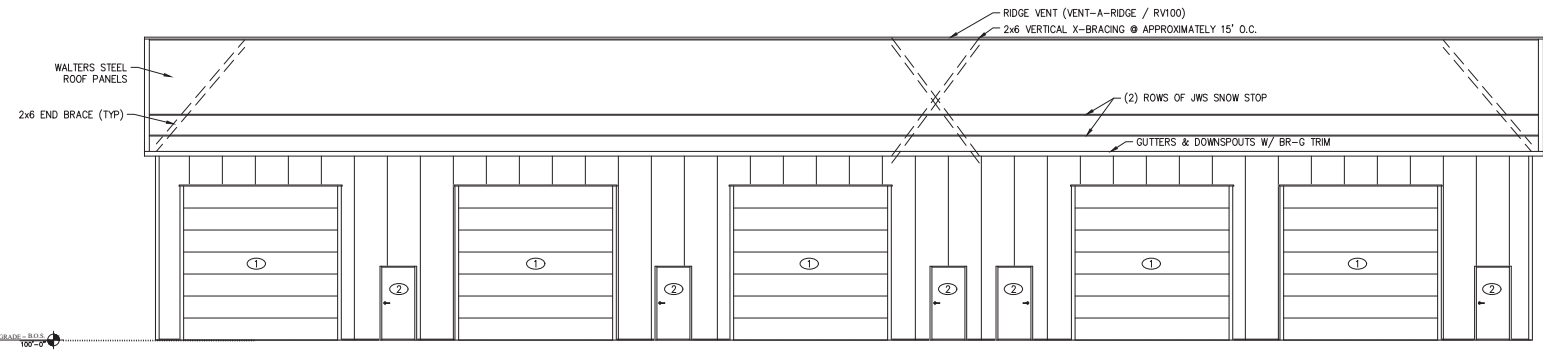


2 FRONT SIDE ELEVATION
A1 SCALE: 1/8" = 1'-0"

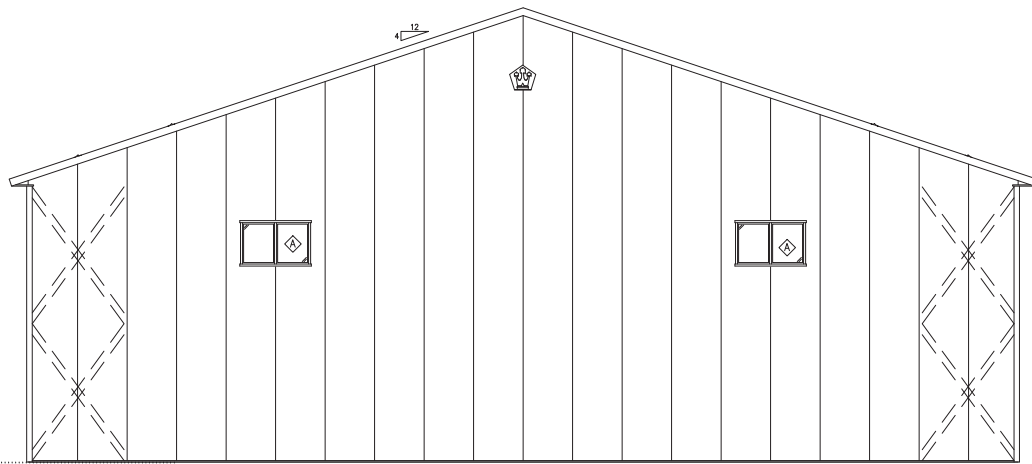

NOTE:
SAME AS SHEET A1
EXCEPT FOR ITEMS NOTED

GRADE - B.O.S.
100'-0"

1 RIGHT END ELEVATION
A1.1 SCALE: 3/16" = 1'-0"

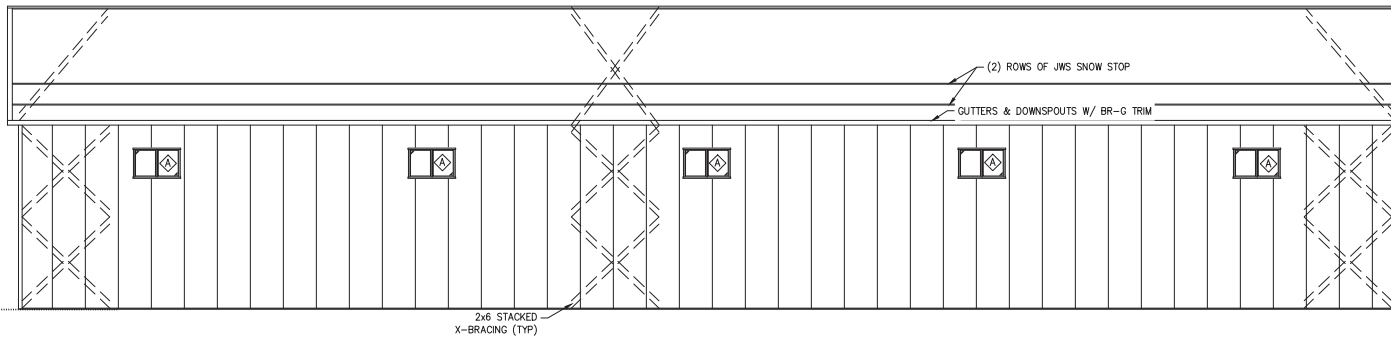

2 BACK SIDE ELEVATION
A1.1 SCALE: 1/8" = 1'-0"

DOOR & WINDOW SCHEDULE			
MAINTAIN LEVEL APPROACH TO ALL WALKDOORS		*FIELD VERIFY ALL WINDOW SILL HEIGHTS*	
TAG	TYPE	ROUGH OPENING W x H	QUANTITY
①	14'x14' OVERHEAD DOOR	14'x14'	5
②	3'x6'-8" THERMAL BREAK WALK DOOR W/INTERCONNECTED DEADBOLT LEVERSET	FIELD VERIFY	9
③	4'x3' HORIZONTAL SLIDING WINDOWS	48"x36"	7



Walters Buildings

Jack Walters & Sons, Corp.
P.O. Box 388
6600 Midland Ct.
Algerton, WI 53002
1-800-558-7800
www.waltersbuildings.com

**DRAWINGS
IN PROGRESS**

OWNER NAME:
TCTS, LLC.

OWNER ADDRESS:
2626 49th DR.
FRANKSVILLE, WI
53126

PROJECT NAME:
60'x125' STORAGE
BUILDING

PROJECT ADDRESS:
2626 49th DR.
FRANKSVILLE, WI
53126

SALES REP / DEALER:
JOSH OBERT

DRAFTER:
DAVID MERKEL

ESTIMATOR:
EVAN ROGERS

LAST SAVED BY:
DMERKEL ON: 12/17/2024

PAPER SIZE:
ARCH PALL BLEED C (18.00 X 24.00 INCHES)

SCALE:
AS NOTED


ENGINEER:
CAYNEN KLESSIG

JOB NUMBER:
94-0805

SHEET NUMBER:


A1.1

WALK DOOR SPECIFICATIONS

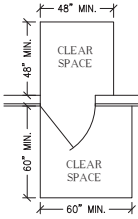

MAINTAIN LEVEL APPROACH TO WALKDOORS
 SLOPES NOT GREATER THAN 1:48 WITH A MAXIMUM RISE OF 30\"/>

36\"/>

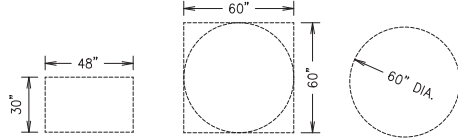

CLEAR FLOOR SPACE

EXIT SPECIFICATIONS

EXITS TO PROVIDE AN APPROVED TYPE ILLUMINATED SIGN BEARING THE WORD "EXIT" IN 6\"/>

EXIT LIGHTS TO PROVIDE NO LESS THAN FIVE FOOTCANDLES OF ILLUMINATION WITH A CONTRAST RATIO NOT LESS THAN 0.5. SHALL BE ILLUMINATED AT ALL TIMES THE BUILDING IS OCCUPIED AND CONNECTED TO AN EMERGENCY ELECTRICAL SYSTEM THAT PROVIDES ILLUMINATION FOR A PERIOD OF NO LESS THAN 90 MINUTES AFTER POWER LOSS.


MEANS OF EGRESS LIGHTING: THE INTENSITY OF FLOOR LIGHTING SHALL NOT BE LESS THAN ONE FOOT CANDLE OF ILLUMINATION AT THE WALKING SURFACE LEVEL.

FIRE EXTINGUISHER SPECIFICATIONS

OWNER TO FURNISH AND INSTALL FIRE EXTINGUISHERS PER NFPA NO. 10

Hazard Occupancy	NFPA TABLE 3-2.1		
	Light (Low)	Ordinary (Moderate)	Extra (High)
Minimum Rated Single Extinguisher	2-A	2-A	4-A*
Maximum Floor Area per Unit of A	3,000 sq. ft.	1,500 sq. ft.	1,000 sq. ft.
Maximum Floor Area per Extinguisher	11,250 sq. ft.	11,250 sq. ft.	11,250 sq. ft.
Maximum Travel Distance to Extinguisher	75 ft.	75 ft.	75 ft.

* Two 1/2 Gallon Water Type Extinguishers can be used to fulfill the requirements of One 4-A Rated Extinguisher.

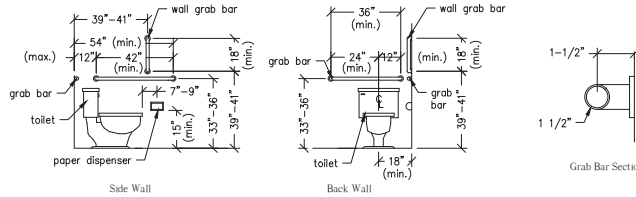

Side Wall

Back Wall

Grab Bar Section

Clear floor space at fixtures
 48" by 56" at water closet
 30" by 48" at lavatory
 60" diameter turning space

TOILET ROOM - MECHANICAL VENTILATION:
 Mechanical ventilation shall be provided in toilet rooms by a mechanical exhaust fan connected to the light switch. Exhaust fan capacity shall be a minimum of two cubic feet per minute per square foot of floor area or 80 cfm. per fixture - whichever is greater.

TOILET ROOM - ENTIRE FLOOR AND SIDEWALLS TO A HEIGHT OF NOT LESS THAN 6" SHALL BE MADE OF A MATERIAL IMPERVIOUS TO WATER

TOILET ROOM WALLS AND CEILING - THE WALLS AND CEILING SHALL BE COVERED WITH SMOOTH NONABSORBANT MATERIAL. INTERIOR SURFACE OF WALLS AND PARTITIONS SHALL BE OF LIGHT COLOR TO IMPROVE ILLUMINATION AND FACILITATE CLEANING.

BATHROOM DOOR IS EQUIPED WITH PRIVACY LOCK. BUILDING WILL NOT HAVE MORE THAN 10 EMPLOYEES AND 25 PATRONS AT ANY GIVEN TIME.

DOOR & WINDOW SCHEDULE

MAINTAIN LEVEL APPROACH TO ALL WALKDOORS		*FIELD VERIFY ALL WINDOW SILL HEIGHTS*	
TAG	TYPE	ROUGH OPENING W x H	QUANTITY
①	14'x14' OVERHEAD DOOR	14'x14'	5
②	3'x6'-8" THERMAL BREAK WALK DOOR W/INTERCONNECTED DEADBOLT LEVERSET	FIELD VERIFY	9
③	4'x3' HORIZONTAL SLIDING WINDOWS	48"x36"	7

Walters Buildings
 Jack Walters & Sons, Corp.
 P.O. Box 388
 6600 Midland Ct.
 Alton, WI 53002
 1-800-558-7800
 www.waltersbuildings.com

DRAWINGS IN PROGRESS

OWNER NAME:
 TCTS, LLC.

OWNER ADDRESS:
 2626 49th DR.
 FRANKSVILLE, WI
 53126

PROJECT NAME:
 60x125 STORAGE
 BUILDING

PROJECT ADDRESS:
 2626 49th DR.
 FRANKSVILLE, WI
 53126

SALES REP / DEALER:
 JOSH OBERT

DRAFTER:
 DAVID MERKEL

ESTIMATOR:
 EVAN ROGERS

LAST SAVED BY:
 DMERKEL ON: 12/17/2024

PAPER SIZE:
 ARCH PALL BLEED C (18.00 X 24.00 INCHES)


SCALE:
 AS NOTED

ENGINEER:
 CAYNEN KLESSIG

JOB NUMBER:
 94-0805

SHEET NUMBER:

A2

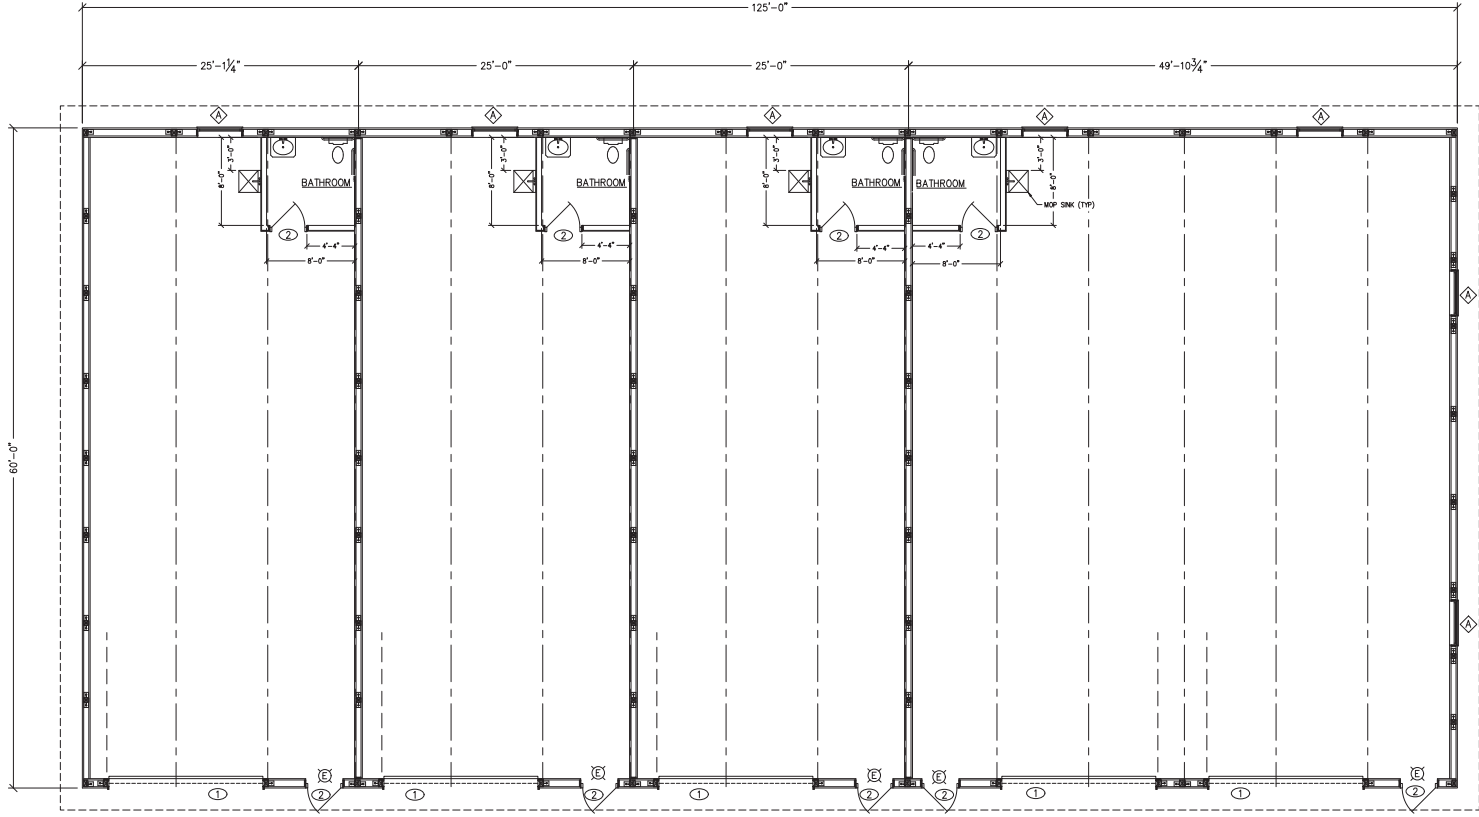



Walters Buildings

Jack Walters & Sons, Corp.
P.O. Box 388
6600 Midland Ct.
Altona, WI 53002
1-800-558-7800
www.waltersbuildings.com

**DRAWINGS
IN PROGRESS**

OWNER NAME:
TCTS, LLC.

OWNER ADDRESS:
2626 49th DR.
FRANKSVILLE, WI
53126

PROJECT NAME:
60x125 STORAGE
BUILDING

PROJECT ADDRESS:
2626 49th DR.
FRANKSVILLE, WI
53126

SALES REP / DEALER:
JOSH OBERT

DRAFTER:
DAVID MERKEL

ESTIMATOR:
EVAN ROGERS

LAST SAVED BY:
DMERKEL ON: 12/17/2024

PAPER SIZE:
ARCH PALL BLEED C (18.00 X 24.00 INCHES)

SCALE:
AS NOTED

ENGINEER:
CAYNEN KLESSIG

JOB NUMBER:
94-0805


SHEET NUMBER:

S0

STRONG-BOLT 2 SPECIFICATIONS


CARBON STEEL STRONG-BOLT 2 ANCHOR INSTALLATION INFORMATION

CHARACTERISTIC	SYMBOL	UNITS	NOMINAL ANCHOR DIAMETER CARBON STEEL		CHARACTERISTIC	SYMBOL	UNITS	NOMINAL ANCHOR DIAMETER CARBON STEEL	
			# 3/8"	# 1/2"				# 3/8"	# 1/2"
Minimum Embedment									
Minimum Diameter	D _m	in.	3	4	Specified Yield Strength	f _y	ksi	55,000	
Clear Dia. Diameter	D _c	in.	3	4	Specified Tensile Strength	f _t	ksi	110,000	
Minimum Concrete Hoop Diameter*	H _c	in.	3 1/2	4 1/2	Minimum Tensile and Shear Stress Area	A _{st}	in ²	0.105	0.169
Minimum Embedment Depth	L _m	in.	3 1/2	4 1/2	Concrete and/or Ungrouted Grout	β	lb/in.	63,570	91,370
Effective Embedment Depth	L _e	in.	3 1/2	4 1/2	Additional Data				
Minimum Hoop Diameter	H _m	in.	4	5	1. The information on this sheet is for general information only. It is not intended to be used as a basis for design or construction without the assistance of a qualified professional engineer or architect.				
Minimum Overall Anchor Length	L _o	in.	3 1/2	4 1/2	2. The maximum value of β for 18 ksi minimum carbon steel (Grade 60) is 1.0. For higher strength steel, β shall be determined by testing.				
Minimum Edge Distance	C _m	in.	2	3	3. The minimum concrete cover shall be 2 inches for all diameters of anchors and 1.5 inches for 1/2" diameter anchors.				
Minimum Edge Distance	C _e	in.	2	3	4. The minimum concrete cover shall be 2 inches for all diameters of anchors and 1.5 inches for 1/2" diameter anchors.				
Minimum Spacing	S _m	in.	12	8	5. The minimum spacing between anchors shall be 4 times the diameter of the anchor.				
Minimum Concrete Thickness	T _m	in.	4	5	6. The minimum thickness of concrete shall be 4 times the diameter of the anchor.				

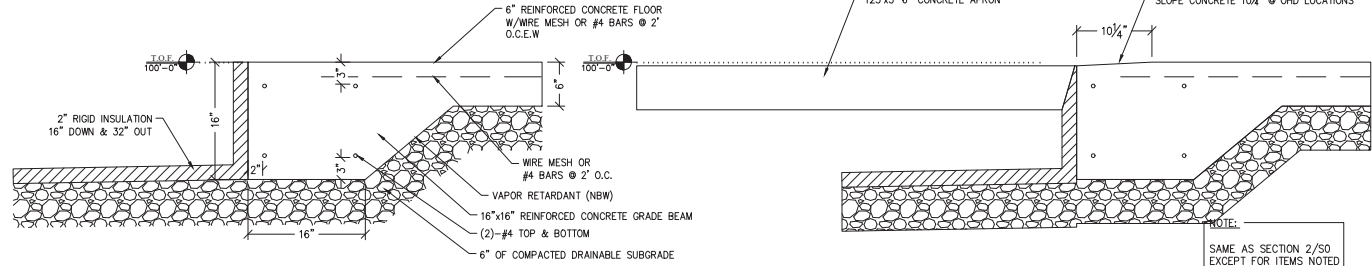

2 DRAWING TAG
SCALE: 1" = 1'-0"

3 DRAWING TAG
SCALE: 1" = 1'-0"

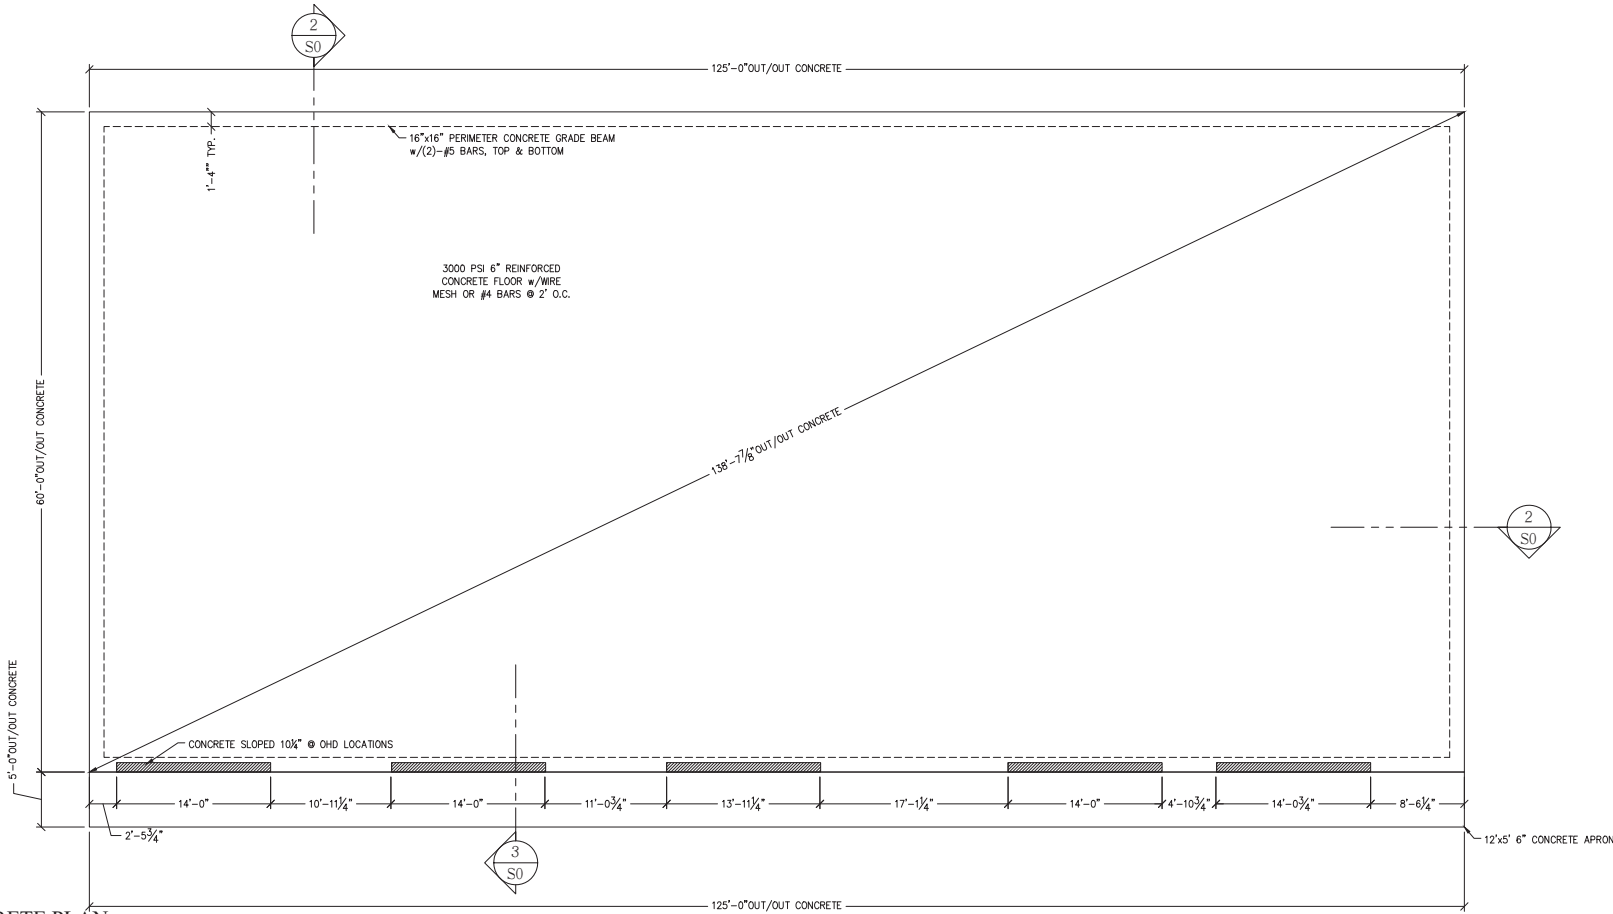

1 CONCRETE PLAN
SCALE: 1/8" = 1'-0"

S0

COLUMN SCHEDULE

TAG	COLUMN TYPE
①	(3)-PLY 2x6 #2 SYP STP LAM COLUMN
②	(4)-PLY 2x8 #1 SYP STP LAM COLUMN



Walters Buildings
 Jack Walters & Sons, Corp.
 P.O. Box 388
 6600 Midland Ct.
 Alton, WI 53002
 1-800-558-7800
 www.waltersbuildings.com

DRAWINGS IN PROGRESS

OWNER NAME:
TCTS, LLC.

OWNER ADDRESS:
2626 49th DR.
FRANKSVILLE, WI
53126

PROJECT NAME:
60x125 STORAGE
BUILDING

PROJECT ADDRESS:
2626 49th DR.
FRANKSVILLE, WI
53126

SALES REP / DEALER:
JOSH OBERT

DRAFTER:
DAVID MERKEL

ESTIMATOR:
EVAN ROGERS

LAST SAVED BY:
DMERKEL ON:12/17/2024

PAPER SIZE:
ARCH PALL BLEED C (18.00 X 24.00 INCHES)



SCALE:
AS NOTED

ENGINEER:
CAYNEN KLESSIG

JOB NUMBER:
94-0805

SHEET NUMBER:

S1

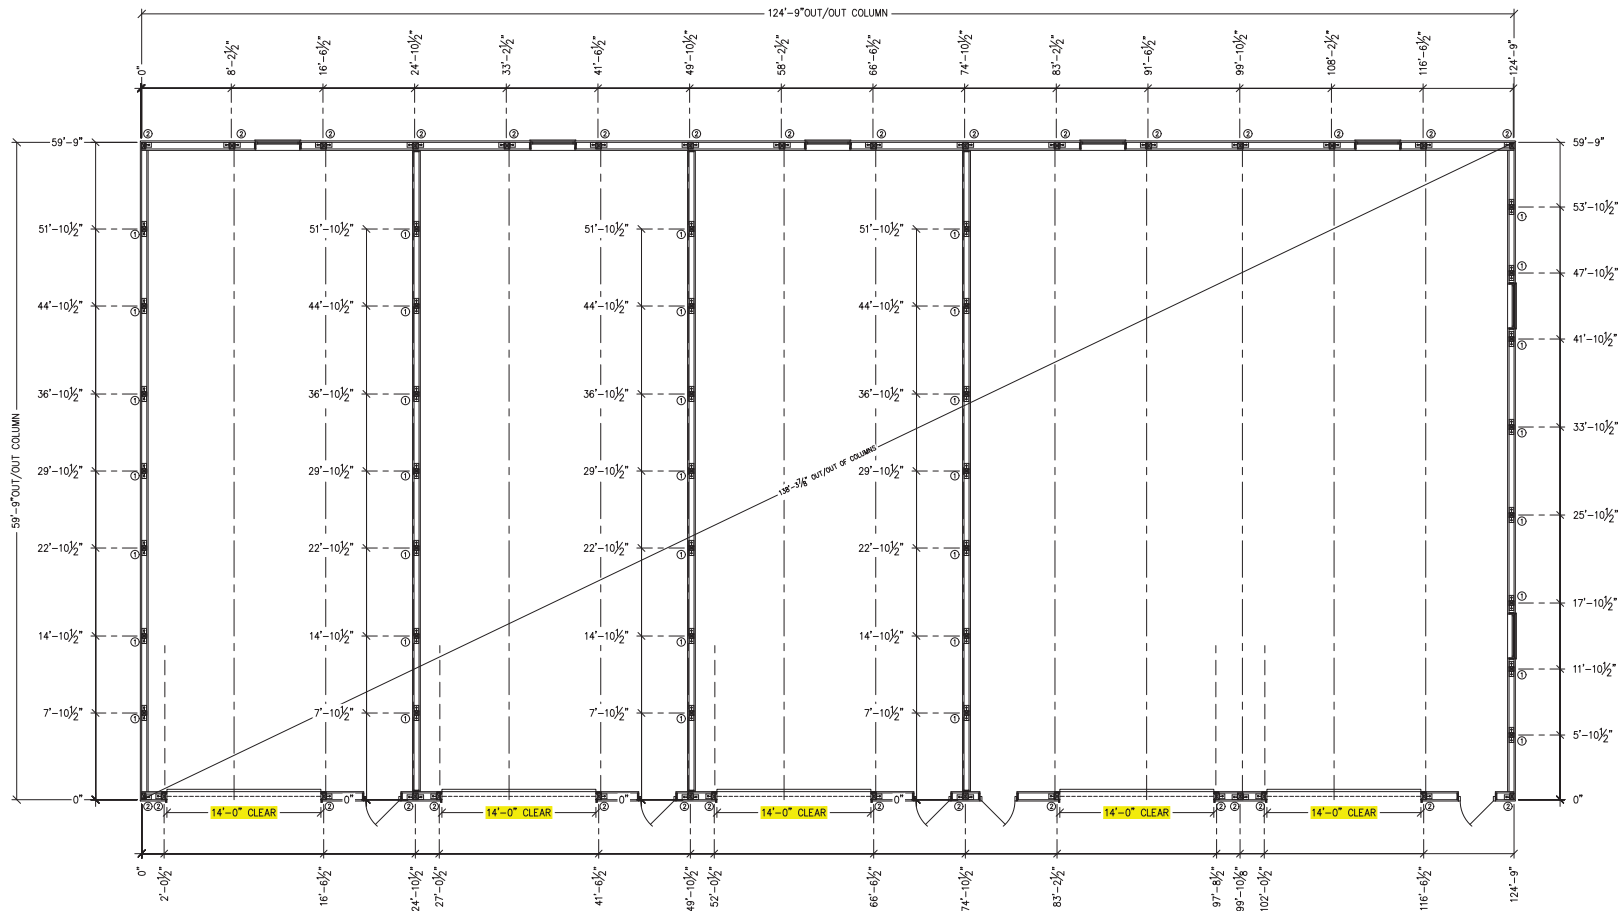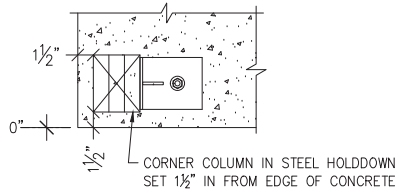

1 COLUMN PLAN
 S1 SCALE: 1/8" = 1'-0"

DOOR & WINDOW SCHEDULE

MAINTAIN LEVEL APPROACH TO ALL WALKDOORS		*FIELD VERIFY ALL WINDOW SILL HEIGHTS*	
TAG	TYPE	ROUGH OPENING W x H	QUANTITY
①	14'x14' OVERHEAD DOOR	14'x14'	5
②	3'x6'-8" THERMAL BREAK WALK DOOR W/INTERCONNECTED DEADBOLT LEVERSET	FIELD VERIFY	9
③	4'x3' HORIZONTAL SLIDING WINDOWS	48"x36"	7



Walters Buildings

Jack Walters & Sons, Corp.
P.O. Box 388
6600 Midland Ct.
Alton, WI 53102
1-800-558-7800
www.waltersbuildings.com

DRAWINGS IN PROGRESS

OWNER NAME:
TCTS, LLC.

OWNER ADDRESS:
2626 49th DR.
FRANKSVILLE, WI 53126

PROJECT NAME:
60'x125' STORAGE BUILDING

PROJECT ADDRESS:
2626 49th DR.
FRANKSVILLE, WI 53126

SALES REP / DEALER:
JOSH OBERT

DRAFTER:
DAVID MERKEL

ESTIMATOR:
EVAN ROGERS

LAST SAVED BY:
DMERKEL ON:12/17/2024

PAPER SIZE:
ARCH PALL BLEED C (18.00 X 24.00 INCHES)

SCALE:
AS NOTED


ENGINEER:
CAYNEN KLESSIG

JOB NUMBER:
94-0805

SHEET NUMBER:

S2

*ATTIC DRAFTSTOP
-7/8" OSB ONE SIDE
OF TRUSS
w/ 2x4 BBP.
EXTENDS INTO
OVERHANGS

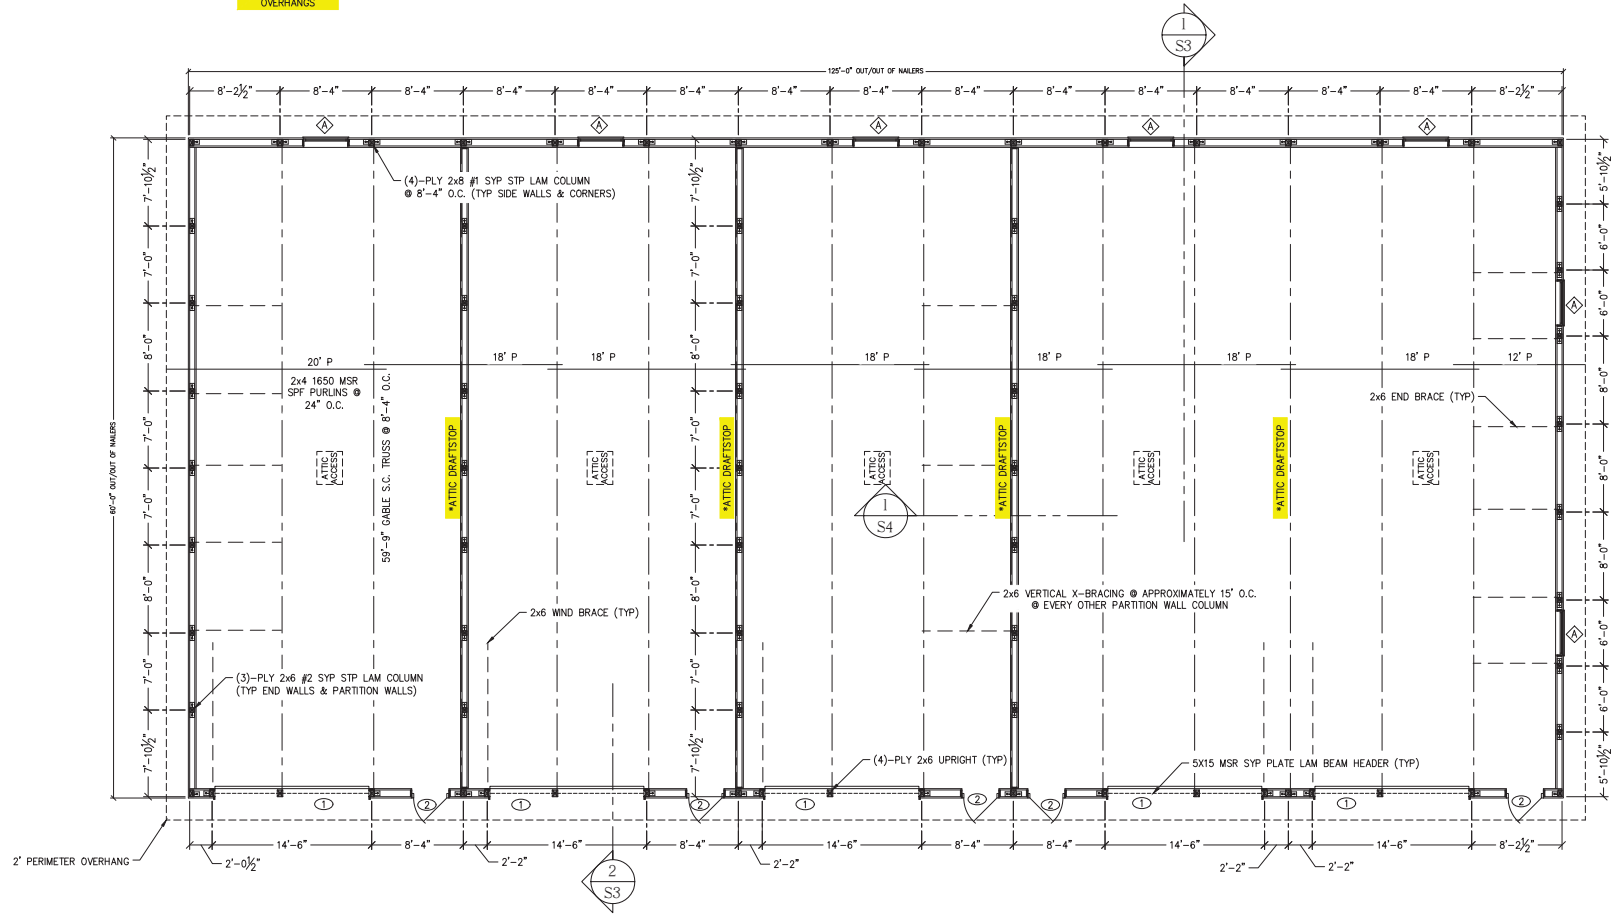

1 FRAMING PLAN
SCALE: 1/8" = 1'-0"

DOOR & WINDOW SCHEDULE

MAINTAIN LEVEL APPROACH TO ALL WALKDOORS		*FIELD VERIFY ALL WINDOW SILL HEIGHTS*	
TAG	TYPE	ROUGH OPENING W x H	QUANTITY
①	14'x14' OVERHEAD DOOR	14'x14'	5
②	3'x6'-8" THERMAL BREAK WALK DOOR W/INTERCONNECTED DEADBOLT LEVERSET	FIELD VERIFY	9
③	4'x3' HORIZONTAL SLIDING WINDOWS	48"x36"	7



Walters Buildings

Jack Walters & Sons, Corp.
P.O. Box 388
6600 Midland Ct.
Altona, WI 53002
1-800-558-7800
www.waltersbuildings.com

DRAWINGS IN PROGRESS

OWNER NAME:
TCTS, LLC.

OWNER ADDRESS:
2626 49th DR.
FRANKSVILLE, WI
53126

PROJECT NAME:
60'x125' STORAGE
BUILDING

PROJECT ADDRESS:
2626 49th DR.
FRANKSVILLE, WI
53126

SALES REP / DEALER:
JOSH OBERT

DRAFTER:
DAVID MERKEL

ESTIMATOR:
EVAN ROGERS

LAST SAVED BY:
DMERKEL ON:12/17/2024


PAPER SIZE:
ARCH PALL BLEED C (18.00 X 24.00 INCHES)

SCALE:
AS NOTED

ENGINEER:
CAYNEN KLESSIG

JOB NUMBER:
94-0805

SHEET NUMBER:

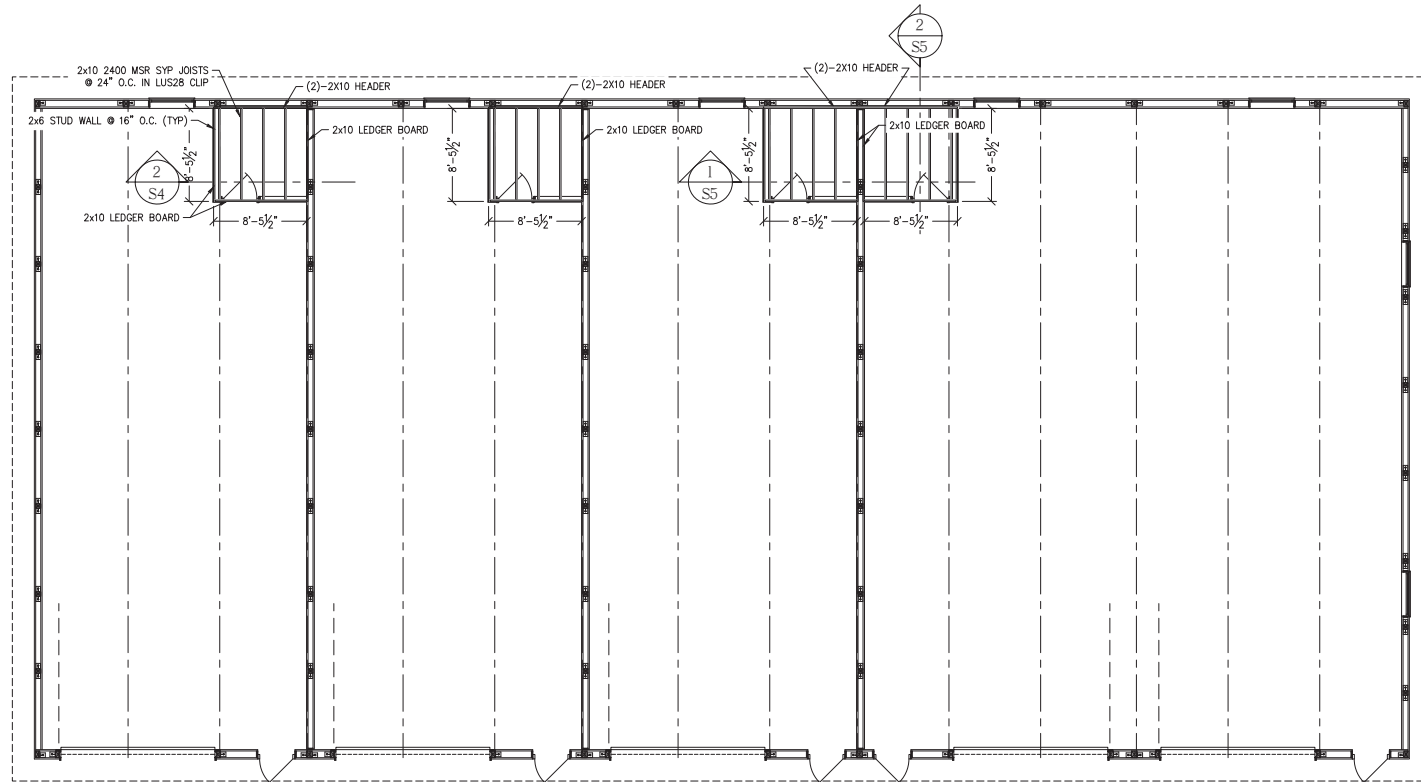

① JOIST LAYOUT PLAN
S2.1 SCALE: 1/8" = 1'-0"

S2.1



Walters Buildings

Jack Walters & Sons, Corp.
P.O. Box 388
6600 Midland Ct.
Algonquin, WI 53002
1-800-558-7800
www.waltersbuildings.com

**DRAWINGS
IN PROGRESS**

OWNER NAME:
TCTS, LLC.

OWNER ADDRESS:
2626 49th DR.
FRANKSVILLE, WI
53126

PROJECT NAME:
60x125 STORAGE
BUILDING

PROJECT ADDRESS:
2626 49th DR.
FRANKSVILLE, WI
53126

SALES REP / DEALER:
JOSH OBERT

DRAFTER:
DAVID MERKEL

ESTIMATOR:
EVAN ROGERS

LAST SAVED BY:
DMERKEL ON: 12/17/2024

PAPER SIZE:
ARCH PALL BLEED C (18.00 X 24.00 INCHES)


SCALE:
AS NOTED

ENGINEER:
CAYNEN KLESSIG

JOB NUMBER:
94-0805

SHEET NUMBER:

S3

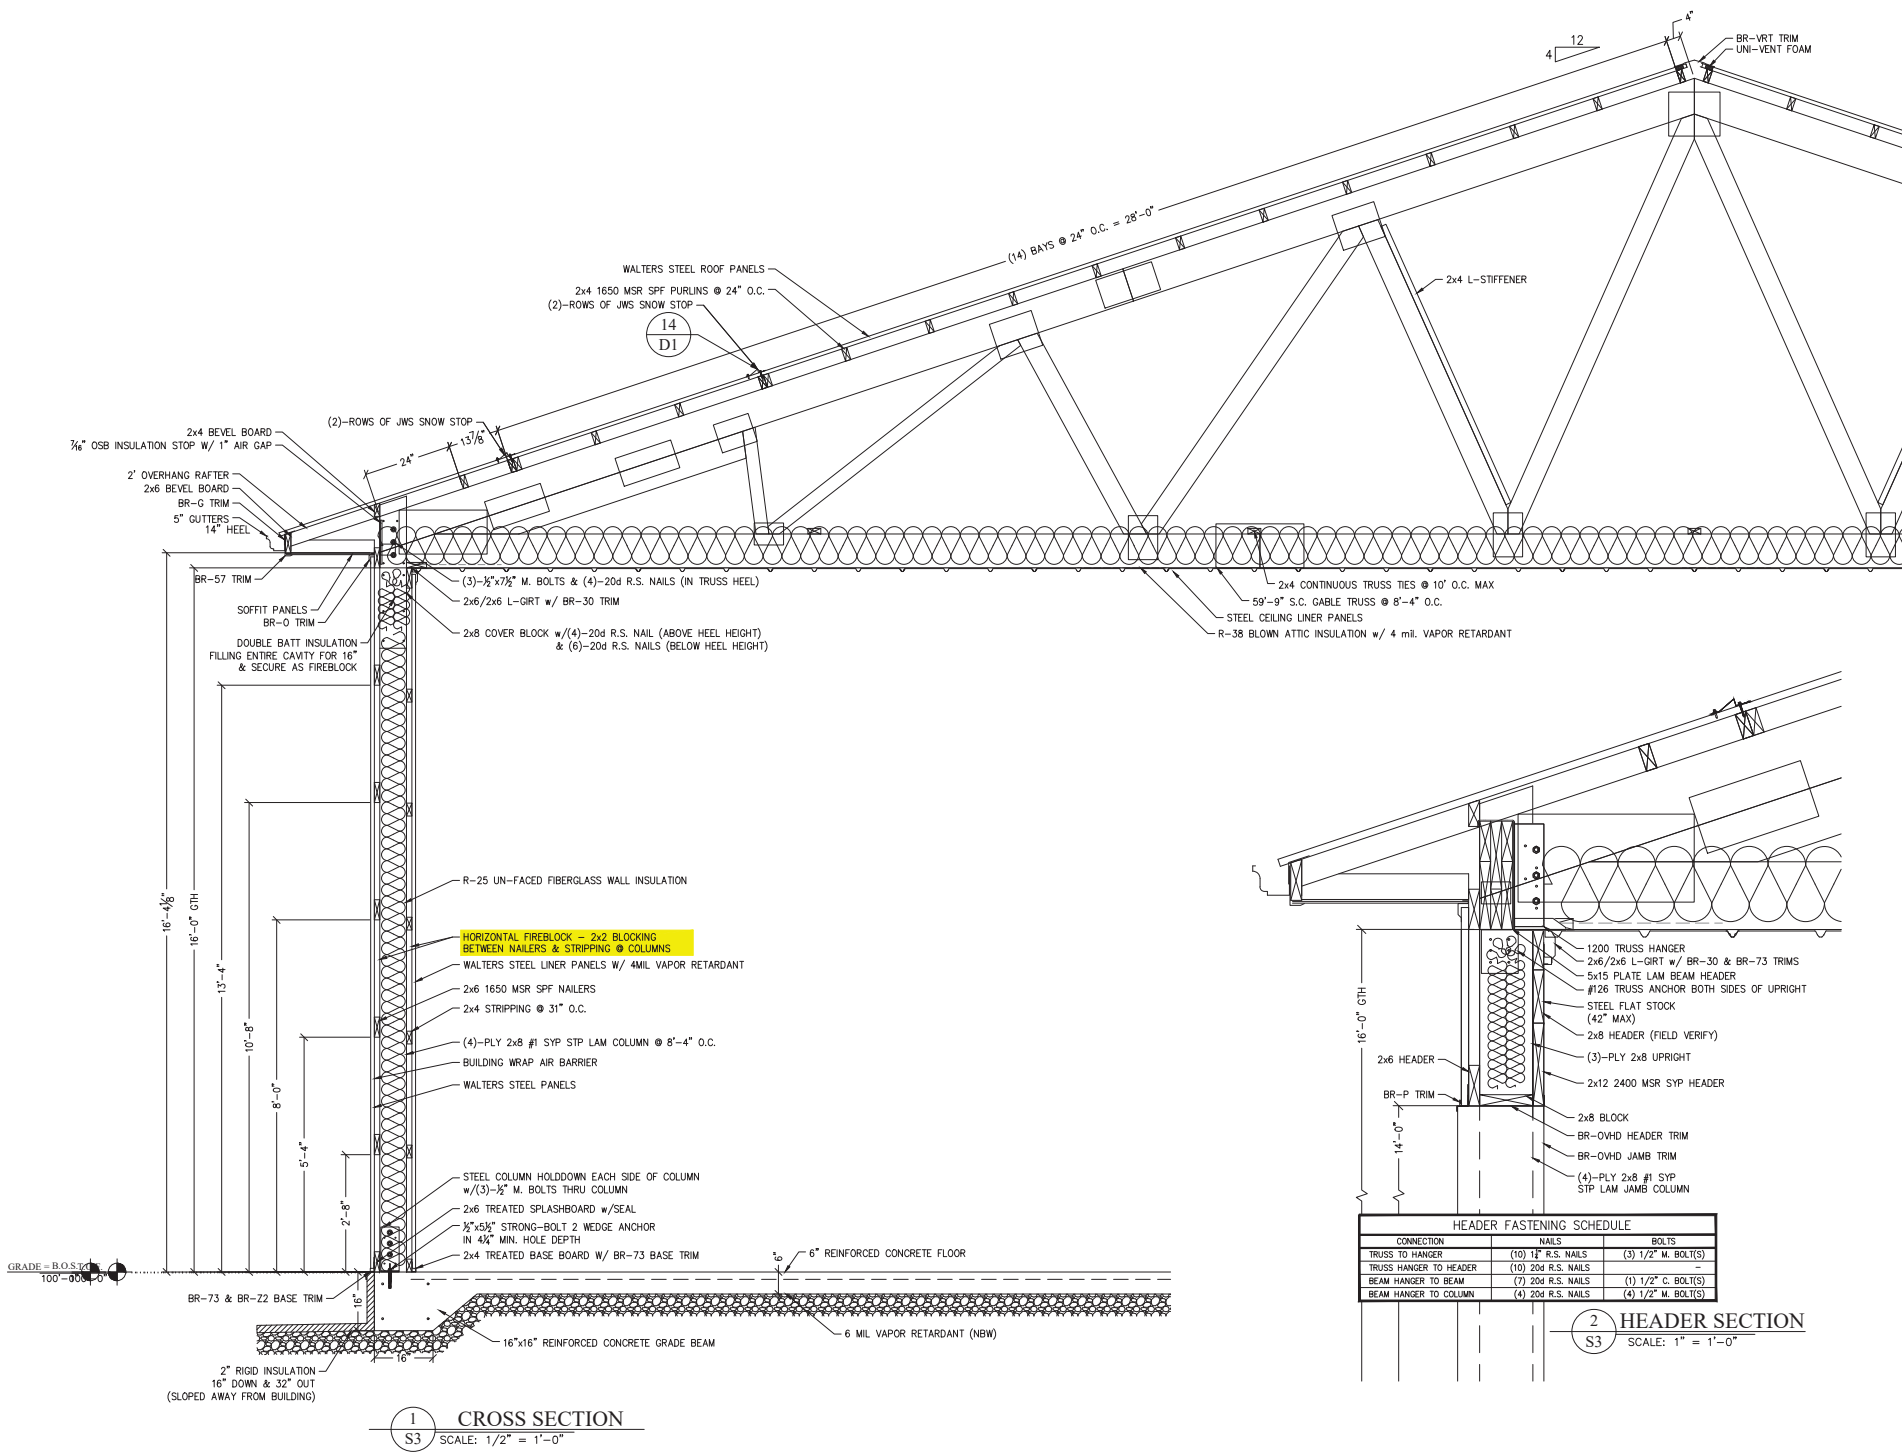



Walters Buildings

Jack Walters & Sons, Corp.
P.O. Box 388
6600 Midland Ct.
Algerton, WI 53002
1-800-558-7800
www.waltersbuildings.com

**DRAWINGS
IN PROGRESS**

OWNER NAME:
TCTS, LLC.

OWNER ADDRESS:
2626 49th DR.
FRANKSVILLE, WI
53126

PROJECT NAME:
60x125 STORAGE
BUILDING

PROJECT ADDRESS:
2626 49th DR.
FRANKSVILLE, WI
53126

SALES REP / DEALER:
JOSH OBERT

DRAFTER:
DAVID MERKEL

ESTIMATOR:
EVAN ROGERS

LAST SAVED BY:
DMERKEL ON:12/17/2024

PAPER SIZE:
ARCH PALL BLEED C (18.00 X 24.00 INCHES)


SCALE:
AS NOTED

ENGINEER:
CAYNEN KLESSIG


JOB NUMBER:
94-0805

SHEET NUMBER:

S4

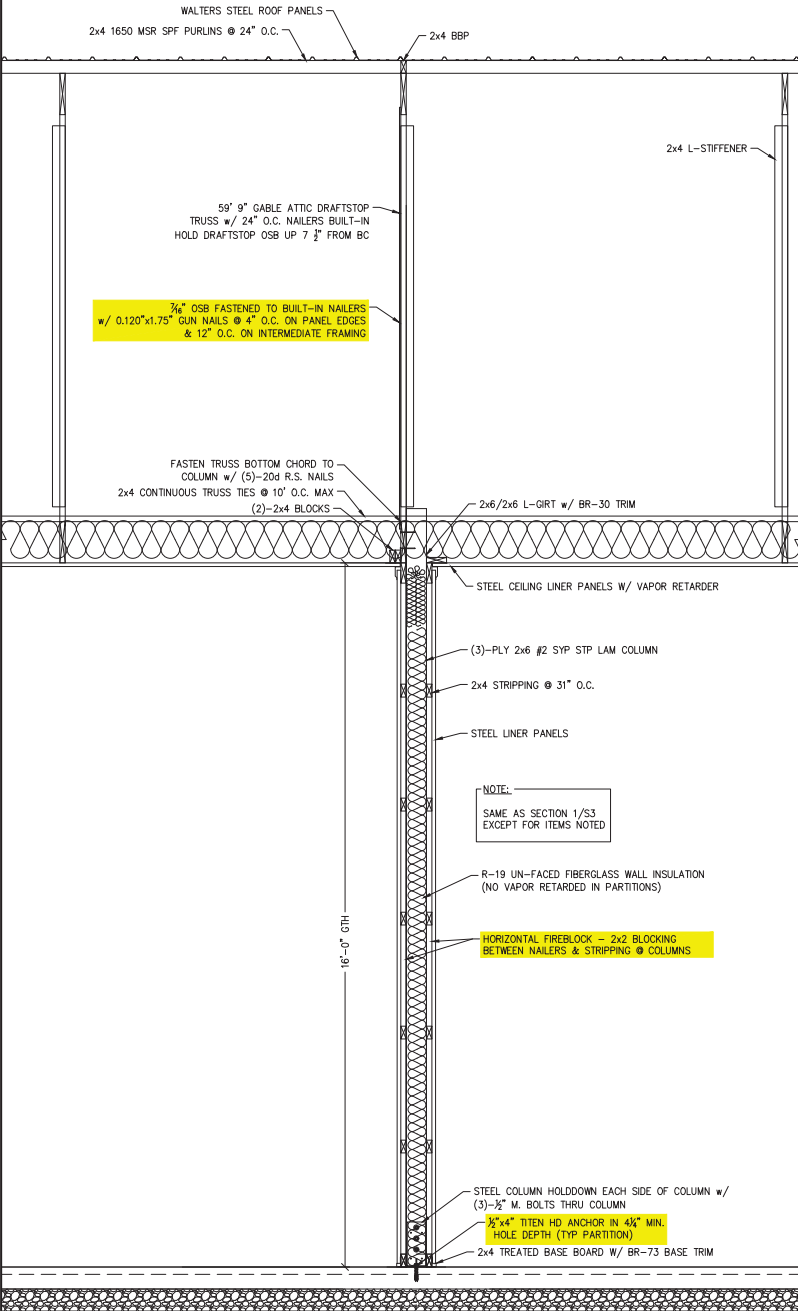

1 CROSS PARTITION
SCALE: 1/2" = 1'-0"

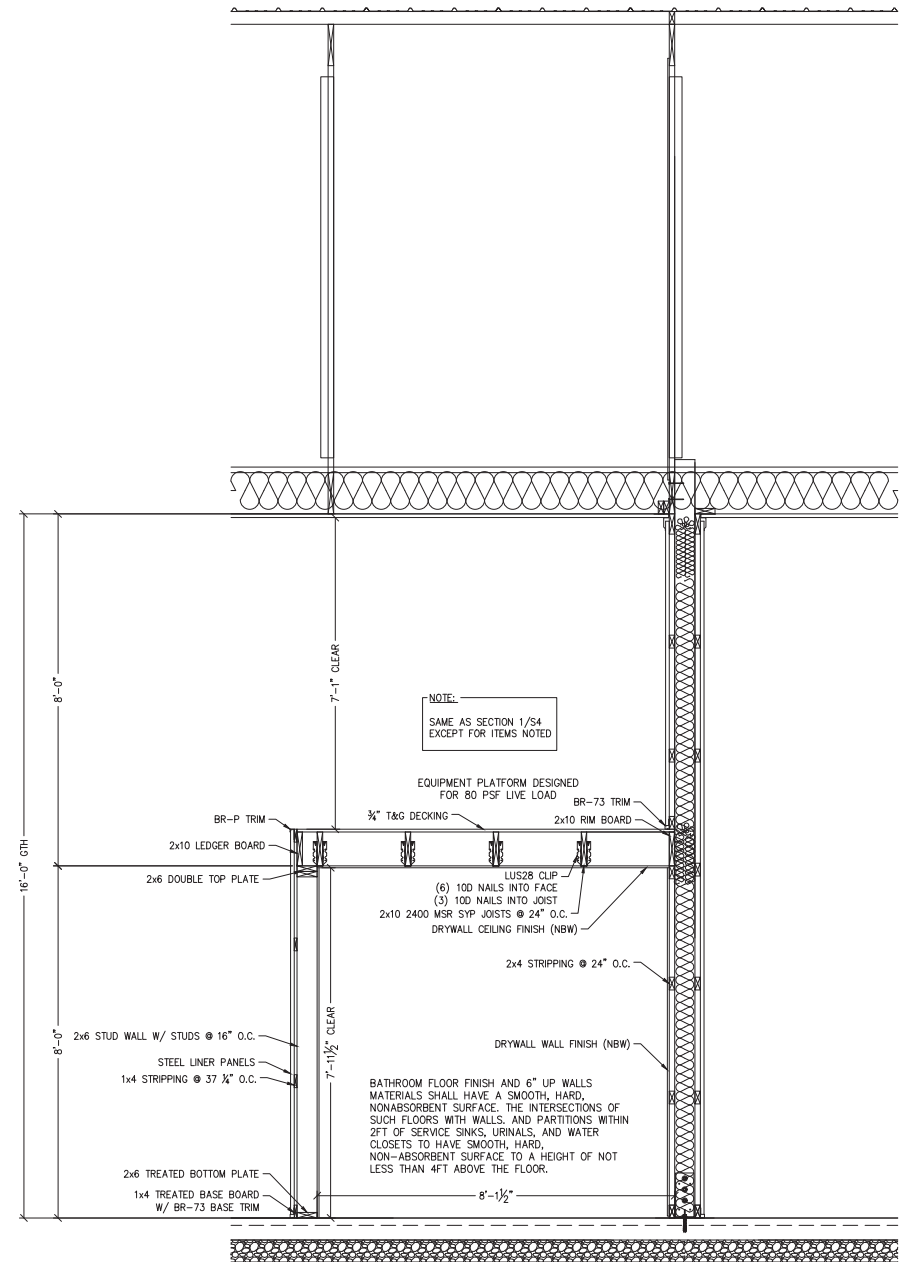

2 PARTITION FRAMING
SCALE: 1/2" = 1'-0"



Walters Buildings

Jack Walters & Sons, Corp.
P.O. Box 388
6600 Midland Ct.
Alton, WI 53002
1-800-558-7800
www.waltersbuildings.com

**DRAWINGS
IN PROGRESS**

OWNER NAME:
TCTS, LLC.

OWNER ADDRESS:
2626 49th DR.
FRANKSVILLE, WI
53126

PROJECT NAME:
60x125 STORAGE
BUILDING

PROJECT ADDRESS:
2626 49th DR.
FRANKSVILLE, WI
53126

SALES REP / DEALER:
JOSH OBERT

DRAFTER:
DAVID MERKEL

ESTIMATOR:
EVAN ROGERS

LAST SAVED BY:
DMERKEL ON: 12/17/2024

PAPER SIZE:
ARCH PALL BLEED C (18.00 X 24.00 INCHES)


SCALE:
AS NOTED

ENGINEER:
CAYNEN KLESSIG


JOB NUMBER:
94-0805

SHEET NUMBER:

S5

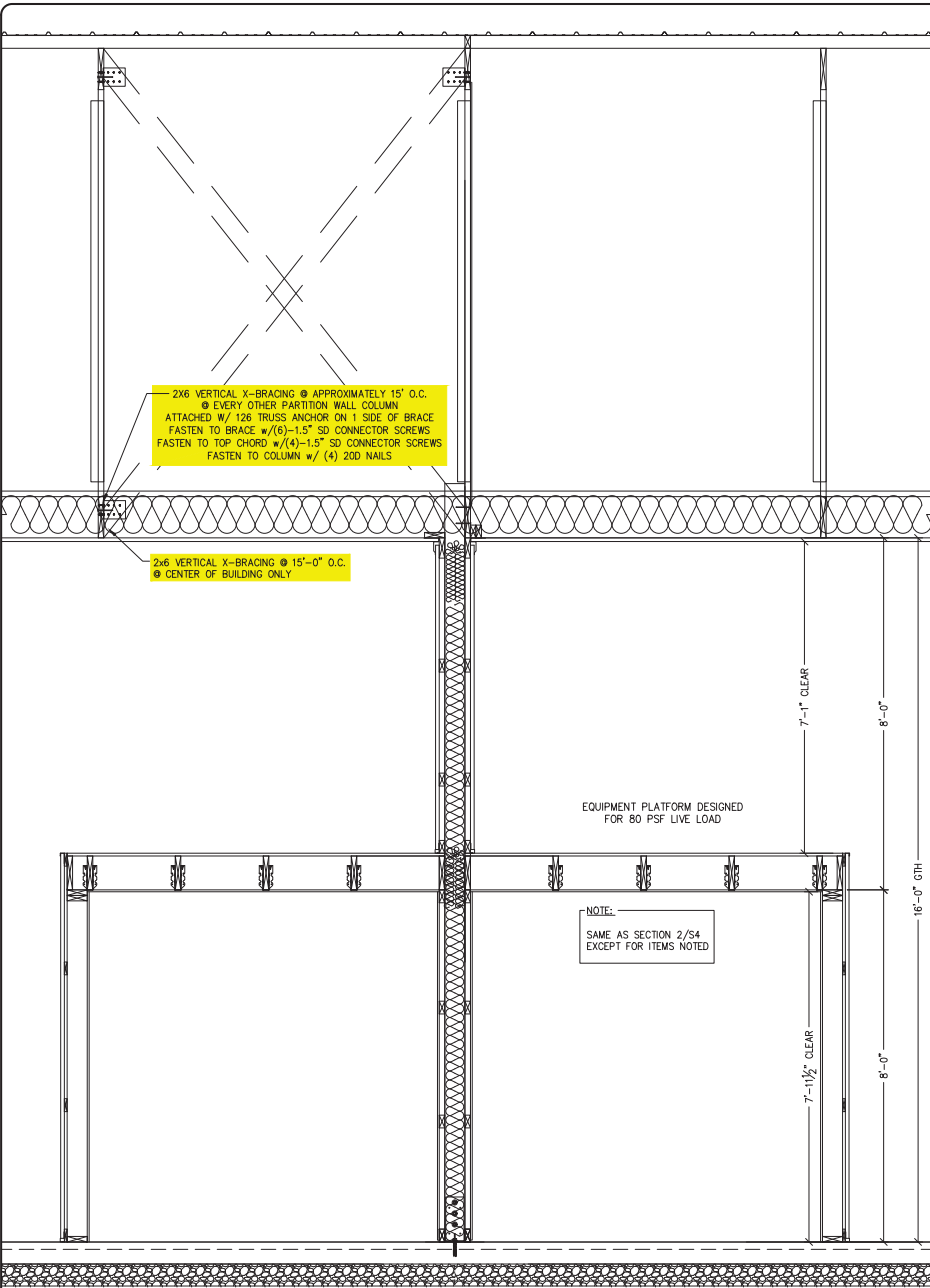


1 PARTITION FRAMING
SCALE: 1/2" = 1'-0"

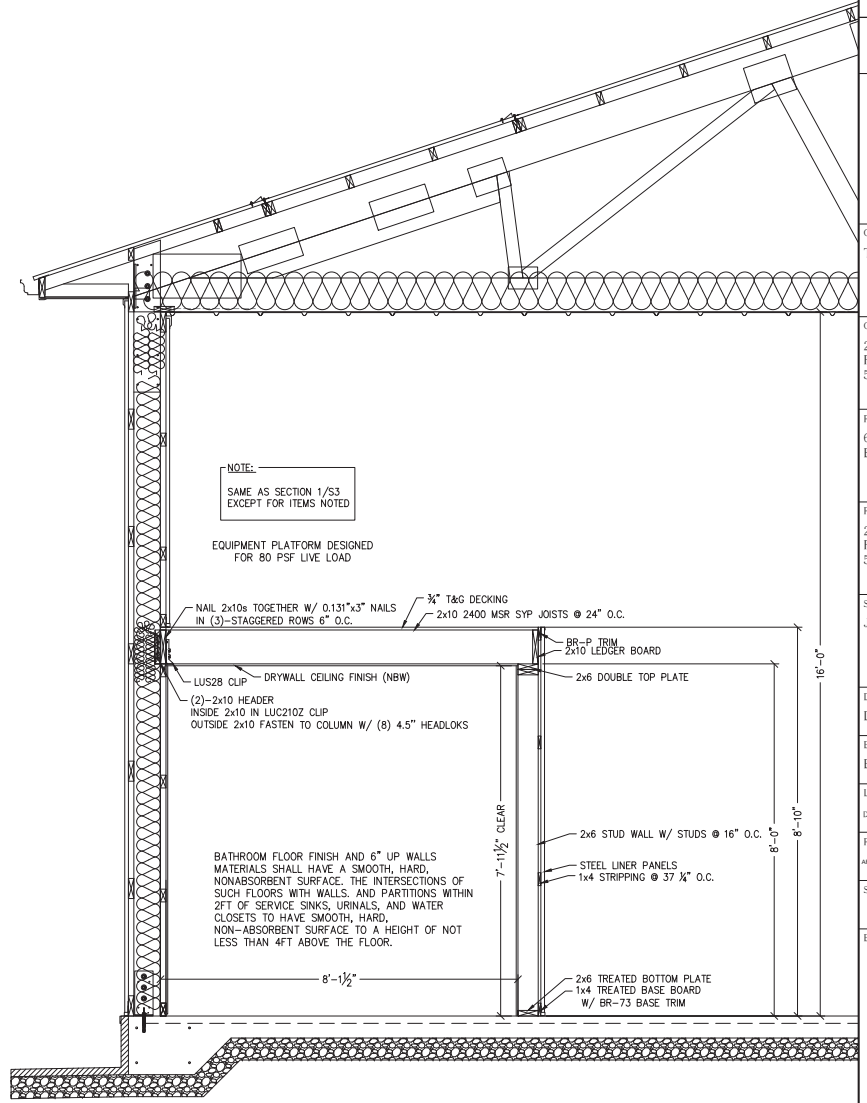


2 SIDE WALL FRAMING
SCALE: 1/2" = 1'-0"

STANDARD TRIM DETAILS

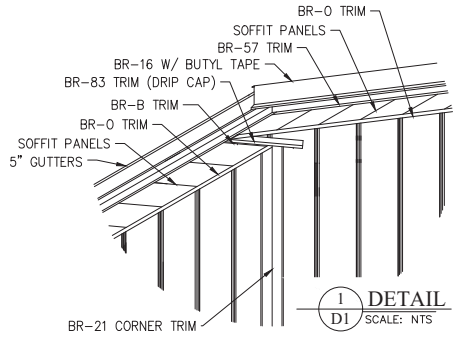


1 DETAIL
D1 SCALE: NTS

STANDARD FRAMING DETAILS

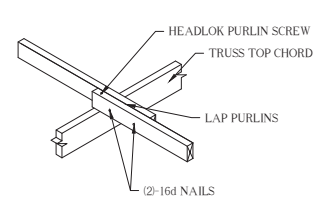


2 DETAIL
D1 SCALE: NTS

STANDARD BRACING DETAILS

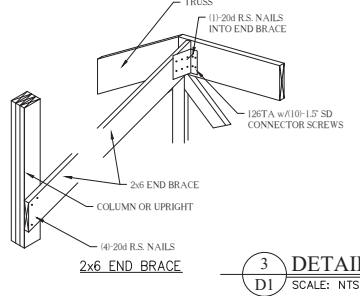


3 DETAIL
D1 SCALE: NTS

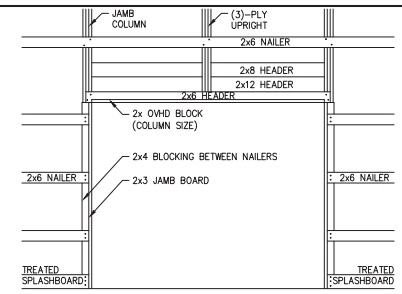


TYPICAL OHD FRAMING @ ENDWALL LOCATIONS
(If Applicable)


4 DETAIL
D1 SCALE: NTS

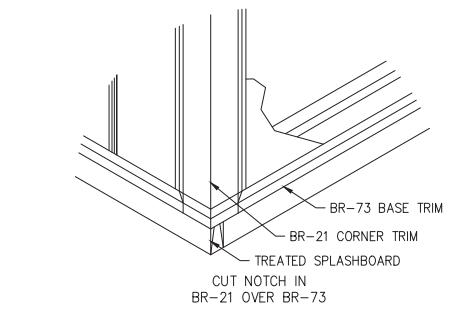


5 DETAIL
D1 SCALE: NTS

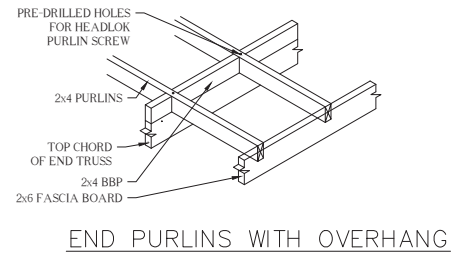


6 DETAIL
D1 SCALE: NTS

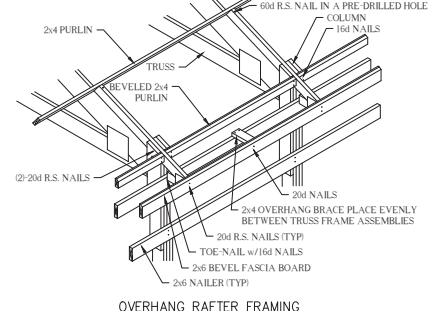


7 DETAIL
D1 SCALE: NTS

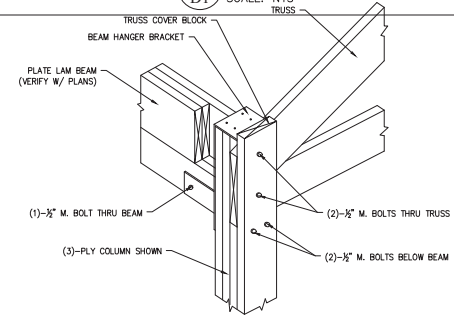


8 DETAIL
D1 SCALE: NTS

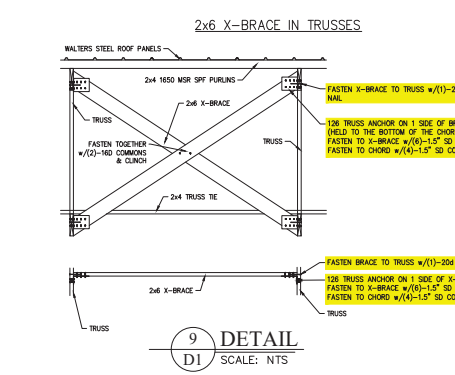


9 DETAIL
D1 SCALE: NTS

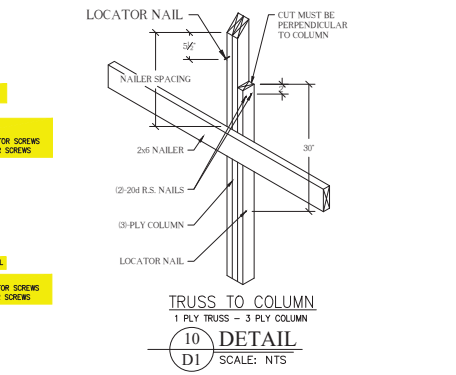

10 DETAIL
D1 SCALE: NTS

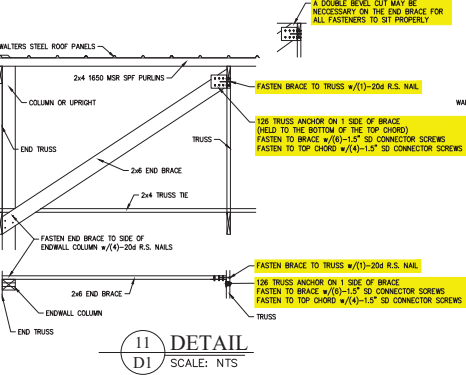


11 DETAIL
D1 SCALE: NTS

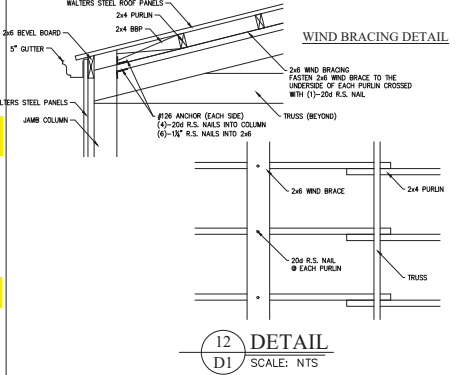


12 DETAIL
D1 SCALE: NTS

ADDITIONAL DETAILS

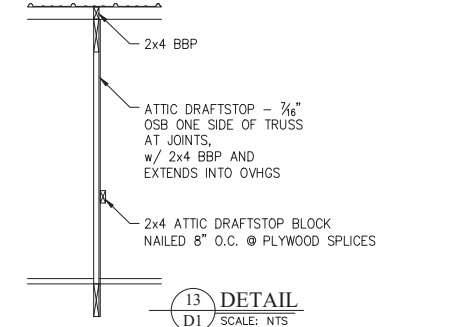

13 DETAIL
D1 SCALE: NTS

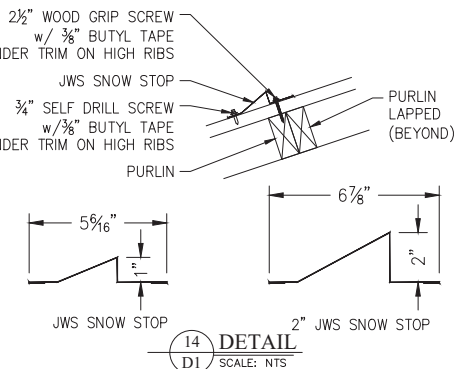

14 DETAIL
D1 SCALE: NTS



15 DETAIL
D1 SCALE: NTS



16 DETAIL
D1 SCALE: NTS

Walters Buildings
Jack Walters & Sons, Corp.
P.O. Box 388
6600 Midland Ct.
Algonquin, WI 53002
1-800-558-7800
www.waltersbuildings.com

DRAWINGS IN PROGRESS

OWNER NAME:
TCTS, LLC.

OWNER ADDRESS:
2626 49th DR.
FRANKSVILLE, WI 53126

PROJECT NAME:
60x125 STORAGE BUILDING

PROJECT ADDRESS:
2626 49th DR.
FRANKSVILLE, WI 53126

SALES REP / DEALER:
JOSH OBERT

DRAFTER:
DAVID MERKEL

ESTIMATOR:
EVAN ROGERS

LAST SAVED BY:
DMERKEL ON:12/17/2024

PAPER SIZE:
ARCH PALL BLEED C (18.00 X 24.00 INCHES)

SCALE:
AS NOTED

ENGINEER:
CAYNEN KLESSIG

JOB NUMBER:
94-0805

SHEET NUMBER:

D1



Walters Buildings
 Jack Walters & Sons, Corp.
 P.O. Box 388
 6600 Midland Ct.
 Alton, WI 53002
 1-800-558-7800
 www.waltersbuildings.com

DRAWINGS IN PROGRESS

OWNER NAME:
TCTS, LLC.

OWNER ADDRESS:
2626 49th DR.
FRANKSVILLE, WI
53126

PROJECT NAME:
60x125 STORAGE
BUILDING

PROJECT ADDRESS:
2626 49th DR.
FRANKSVILLE, WI
53126

SALES REP / DEALER:
JOSH OBERT

DRAFTER:
DAVID MERKEL

ESTIMATOR:
EVAN ROGERS

LAST SAVED BY:
DMERKEL ON: 12/17/2024

PAPER SIZE:
ARCH PALL BLEED C (18.00 X 24.00 INCHES)



SCALE:
AS NOTED

ENGINEER:
CAYNEN KLESSIG

JOB NUMBER:
94-0805

SHEET NUMBER:

T1

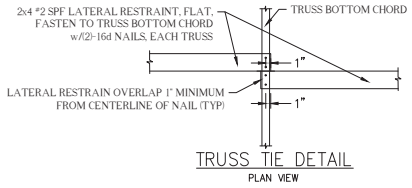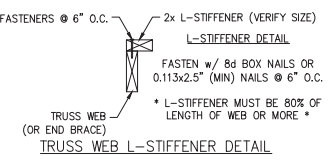

EAGLE METAL TRUSS TIE NOTE
 PER EAGLE METAL PRODUCTS,
 THE BOTTOM CHORD OF METAL PLATED WOOD TRUSSES USED IN POST FRAME CONSTRUCTION MAY BE LATERALLY BRACED AT A SPACING THAT DOES NOT EXCEED 10'-0" O.C. UNDER SPECIFIC CONDITIONS.
 A LIST OF THESE SPECIFIC CONDITIONS & EAGLE METAL LETTER ARE AVAILABLE UPON REQUEST FROM WALTERS BUILDINGS.



STANDARD TRUSS FRAMING DETAILS

Walters Buildings PO Box 388 Alton, WI 53002 Main: (262) 629-5521; Fax: (262) 629-5233								Truss60R 412 - Medium 8ft4in Job: Canon Test Date: 11/14/24 09:14:59 Page: 1 of 1	
SPAN	PITCH	QTY	OHLL	OHR	CANT L	CANT R	PYS	SPACING	WGT PLY
59.0	4/12	1	0.00	0.00	59.0		1	100in	732 lbs
8-4-10	6-3-10	7.80	7-4-10	7.80	7-4-10	7.80	6-3-10	8-4-10	
8-4-10	14-8-9	226.9	20-10-8	313.7	45-6-7	51-4-6	59-9-0		

All plates shown to be Eagle 20 unless otherwise noted.

Loading (per)	General	CSI	Deflection	L / (In)	Allowed
TCLR	25	IK: 70.19	IK: 0.84 (0.7)	Max TL: 1.65 in	L/427 (15.50)
CR	30	RK: 201.20 (4)	RK: 0.11 (0.14)	Max RL: 0.11 in	L/787 (15.50)
TCLR	4 (84)	Rep Max:	Max:	8.56 in	11
RCLR	6	Member D/C/L: 1.15%			

Reaction		By Node		Max Force		Max (in) 1/8 in		Max (in) 1/4 in	
1	2	5.7	3.30	8.72 lbs	-2.50 lbs	-2.91 lbs	-2.91 lbs	229 lbs	
11	12	5.5	3.24	8.72 lbs	-2.50 lbs	-2.91 lbs	-2.91 lbs	229 lbs	

Member Forces Table:

Member ID	Max CS	Min CS	Max Tension	Min Tension	Max Compression	Min Compression
1	5.2	-0.84	-16,074 lbs	1.5	0.70	-16,640 lbs
2	5.3	-0.85	-16,855 lbs	1.6	0.66	-15,378 lbs
3	11.2	0.86	17,681 lbs	-1.5	0.33	-15,742 lbs
4	12.3	0.70	18,513 lbs	-1.46	0.83	-13,794 lbs
5	12.9	0.50	1,804 lbs	-1.19	0.16	-4,223 lbs

ALL PERSONS FABRICATING, HANDLING, DIRECTING OR INSTALLING ANY TRUSS BASED UPON THIS TRUSS DESIGN DRAWING ARE INSTRUCTED TO REFER TO ALL OF THE NOTES ON THIS DRAWING AND ANY SUPPLEMENTAL NOTES TO THE EAGLE METAL PRODUCTS DESIGN NOTES ISSUED WITH THIS DESIGN AND MAKE A RECORD OF ANY REQUESTS. DESIGN VALIDITY ONLY WHEN EAGLE METAL CONNECTORS ARE USED.

TracBall® Truss Software v5.64(31)
Eagle Metal Products